

NOTES: (SEE SHEET 2 FOR EXISTING CONDITIONS NOTES)

- 1. THE APPLICANT INTENDS ON DEMOLISHING APPROXIMATELY 2000 SF OF THE EXISTING BUILDING WHICH INCLUDES BOTH RESIDENTIAL AND COMMERCIAL USES.
- 2. THE PORTION OF THE BUILDING TO REMAIN WILL RETAIN ITS CURRENT USES OF
- 3. THE FACADE OF THE REMAINING PORTION OF THE BUILDING WILL BE REPAIRED AND
- 4. THE INTERIOR SPACE OF THE AUTO REPAIR USE WILL BE RENOVATED WITH THE
- 5. A NEW EXTERIOR OVERHEAD DOOR WILL BE INSTALLED TO PROVIDE ACCESS TO THE
- 6. AN ADDITION TO THE REAR OF THE BUILDING IS PROPOSED. THE ADDITION WILL
- CONTAIN A VEHICLE WASH BAY (438 SF) AND A STORAGE ROOM (220 SF), SEE SHEET

(37,118 SF) BUILDING COVERAGE (25% MAX. F.A.R.) (2,706 SF) 7.3 % 69.1 % (25,658 SF) 30.1 % (11,460 SF)

REQUIRED: 4 SPACES PER 1,000 SF OFFICE (1 SPACE PER 250 SF) 762 SF (OFFICE) / 250 SF PER SPACE = 3.05 SPACES

PROVIDED: 6 SPACES (INCLUDING 1 H.C.)

- 9. THE PROPOSED WASH BAY WILL CONTAIN A WASH WATER RE-CIRCULATION SYSTEM. DIRECT DISCHARGE OF WASH WATER ONTO THE GROUND IS PROHIBITED. THE WASH WATER RECHARGE SYSTEM WILL BE DESIGNED IN CONJUNCTION WITH THE
- 10. SITE LIGHTING IS LIMITED TO 4 BUILDING MOUNTED WALL PACK UNITS WITH 45° SHIELDS. 3 MOUNTED TO THE EXISTING BUILIDNG AND 1 ON THE WASH BAY UNIT.
- 11. A LANDSCAPING PLAN PREPARED BY A PROFESSIONAL LANDSCAPE ARCHITECT IS NOT REQUIRE, THE TOTAL COST OF SITE IMPROVEMENTS IS BELOW THE \$500,000
- 12. ALL PROPOSED LANDSCAPING WHALL BE KEPT IN GOOD CONDITION AND DEAD

LANDSCAPING AND BUFFER NOTES:

A 35 FT LANDSCAPE BUFFER COMPRISED OF A 6 FT TALL STOCKADE FENCE, RAIN GARDEN, LAWN AREA AND 4 TREES IS PROPOSED ALONG THE ABUTTING A RESIDENTIAL

A 28 FT BUFFER COMPRISED OF LAWN IS PROPOSED ALONG A PORTION THE WESTERN LOT LINE, THE EXISTING CHAIN-LINK FENCE WILL REMAIN (ON ABUTTING LOT) A 10 FT

A 12 FT BUFFER COMPRISED OF LAWN AND 3 TREES IS PROPOSED ALONG A PORTION OF THE EASTERN LOT LINE. THE EXISTING STOCKADE FENCE WILL REMAIN (ON ABUTTING

- BUILDING PERMIT ISSUED FOR THE CONSTRUCTION OF A 36' x 60' ADDITION FOR RESTORATION AND SALES OF FOREIGN AUTOMOBILES, THIS IS THE PORTION OF THE
- CEASE AND DESIST ORDER ISSUED FOR CONSTRUCTION IT WAS DETERMINED THE BUILDING WAS WITHIN THE 15 FOOT SIDE YARD SETBACK. THE BUILDING PERMIT WAS ISSUED USING A PARCEL SURVEY THAT AFTER THE FACT WAS DETERMINED TO BE IN ERROR. THE BUILDING WAS INTENDED TO BE CONSTRUCT 15 FEET FROM THE SIDE SETBACK. THE SIDE SETBACK HAS SINCE BEEN INCREASED FROM 15 FEET TO 30 FEET
- LETTER FROM TOWN COUNCIL TO THE BOARD OF SELECTMAN ADVISING THAT THE
- 4. NO FURTHER DISCUSSION WAS NOTED IN THE TOWN FILES AND PRESUMABLY THE CONSTRUCTION OF THE BUILDING WAS ALLOWED TO CONTINUE.
- ZBA CASE #1286 APPEAL FROM AN ADMINISTRCTIVE DICISION ALLOWING
- GRANDFATHERED PARKING WITHIN THE 50 FOOT FRONT SETBACK. 6. NOVEMBER 17, 2015 - APPROVED
- ZBA CASE #PZ6636 REQUEST FOR APPROVAL OF A VARIANCE TO CONSTRUCT AN ADDITION CONSISTING OF A 438 SF VEHICLE WASH BAY AND A 220 SF STORAGE AREA WITHIN THE SIDE YARD SETBACK.


APPROVED BY AMHERST PLANI	NING BOARD
ON:	CERTIFIED BY
CHAIRMAN:	AND
SECRETARY:	

F NEW HAN KEVIN ANDERSON No. 14746

SITE

SP-

SHEET FILE: 3772103A.dwg PROJECT 3772.03 SHEET NO. 1 OF 6

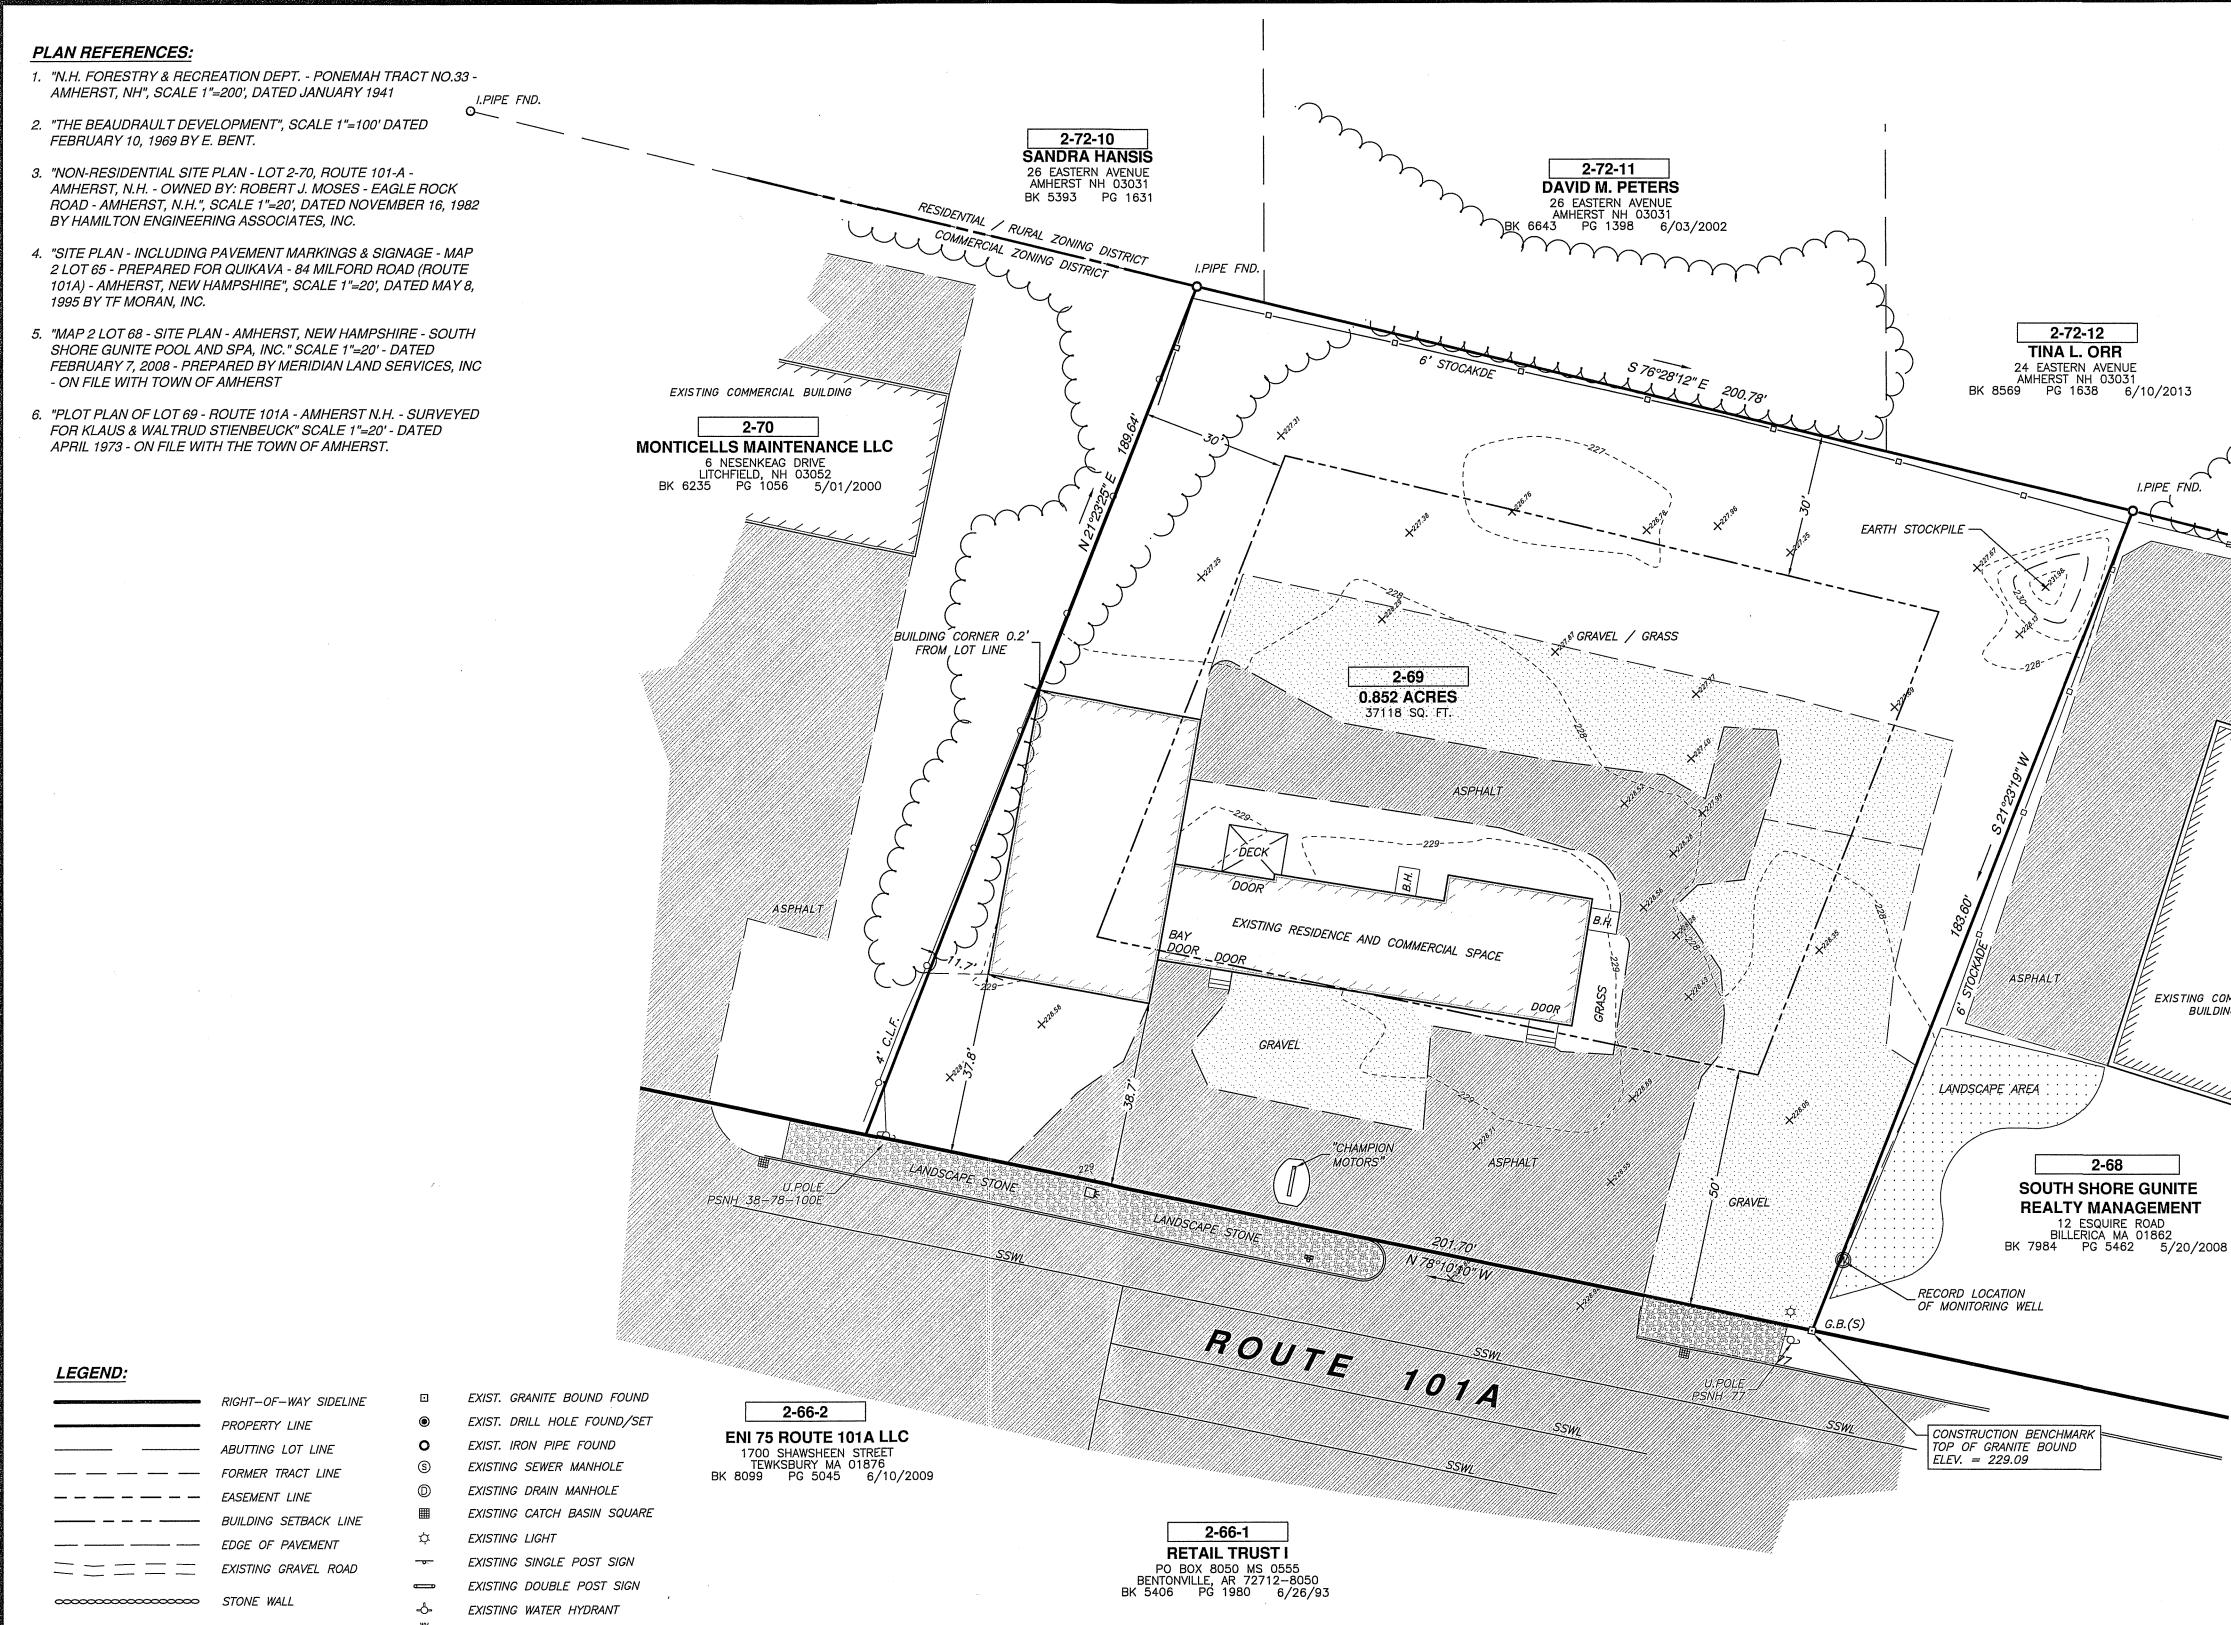

CERTIFICATION:

"I CERTIFY THAT THE STREET LINE(S), TOPOGRAPHY AND PHYSICAL FEATURES ARE ACCURATE AND TRUE." **EXISTING CONDITIONS PLAN** LAND OF


SALAS REALY LLC

TAX MAP 2 LOT 69

AMHERST, NEW HAMPSHIRE

SCALE: 1" = 20'

FEBRUARY 1, 2016

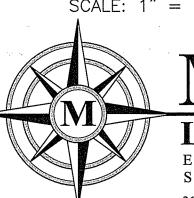

MERIDIAN LAND SERVICES, INC. ENGINEERING | SURVEYING | PERMITTING

SOIL & WETLAND MAPPING | SEPTIC DESIGN 31 OLD NASHUA ROAD, AMHERST, NH 03031 MERIDIANLANDSERVICES.COM

TEL. 603-673-1441 FAX 603-673-1584

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PROJECT NO. 3772.03

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GRAPHIC SCALE

2-23 EXISTING TAX MAP AND LOT NUMBER

EXISTING WATER VALVE

EXISTING SHUT-OFF

EXISTING GAS VALVE

EXISTING WELL

__ | __ | __ ---___ ---__________ __ | __ | __ A | --___ -- | -- | --C/O DR CK REV. DATE DESCRIPTION

EXISTING BUILDING

EXISTING TREE LINE

THE PURPOSE OF THIS PLAN IS TO SHOW THE EXISTING CONDITIONS FOR PARCEL MAP 2 LOT 69. OWNER OF RECORD SALAS REALTY LLC HCRD BOOK 8671 PAGE 1554 (JUNE 30, 2014) REFERENCING THE ZONING MAP OF AMHERST, THE PARCEL IS SITUATED IN THE COMMERICAL ZONING DISTRICT. MINIMUM DIMENSIONAL REQUIREMENTS ARE: FRONTAGE-200 FT, LAND AREA - 1 ACRE, 20 FT FRONT SETBACKS 50 FT. TO 100 FT. DEPENDING ON LANDSCAPE BUFFER, SIDE AND REAR YARD SETBACK IS 30 FT. 4. FEMA DFIRM PANEL NUMBER 33011C0487D, EFFECTIVE DATE SEPTEMBER 29, 2009, GRAPHICALLY DEPICTS THE PARCEL OUTSIDE THE 1% ANNUAL CHANCE FLOOD ZONE. THE PARCEL IS LOCATED WITHIN THE AQUIFER CONSERVATION AND WELLHEAD PROTECTION DISTRICT. 6. THIS PLAN IS THE RESULT OF FIELD SURVEYS MADE BY THIS OFFICE ON EXISTING COMERCIAL AUGUST 10, 2015. BUILDING THE BOUNDARY SHOWN IS PER REFERENCE PLANS AND DOES NOT

REPRESENT A DETERMINATION MADE BY THIS OFFICE.


EXISTING PARCEL AREA CALCULATIONS: TOTAL AREA OF PARCEL (37,118 SF) (4,066 SF) BUILDING COVERAGE IMPERVIOUS COVERAGE *63.7 %* (23,631 SF) (13,487 SF) OPEN SPACE *36.3* %

EASTERN AVENUE

LOCUS SCALE: 1"=1000'

THERE ARE NO DEFINED PARKING SPACES LOCATED ON THE PARCEL

10. THE PARCEL IS SERVICED BY MUNICIPAL WATER AND PRIVATE LEACHING FIELD SEPTIC DISPOSAL SYSTEM.

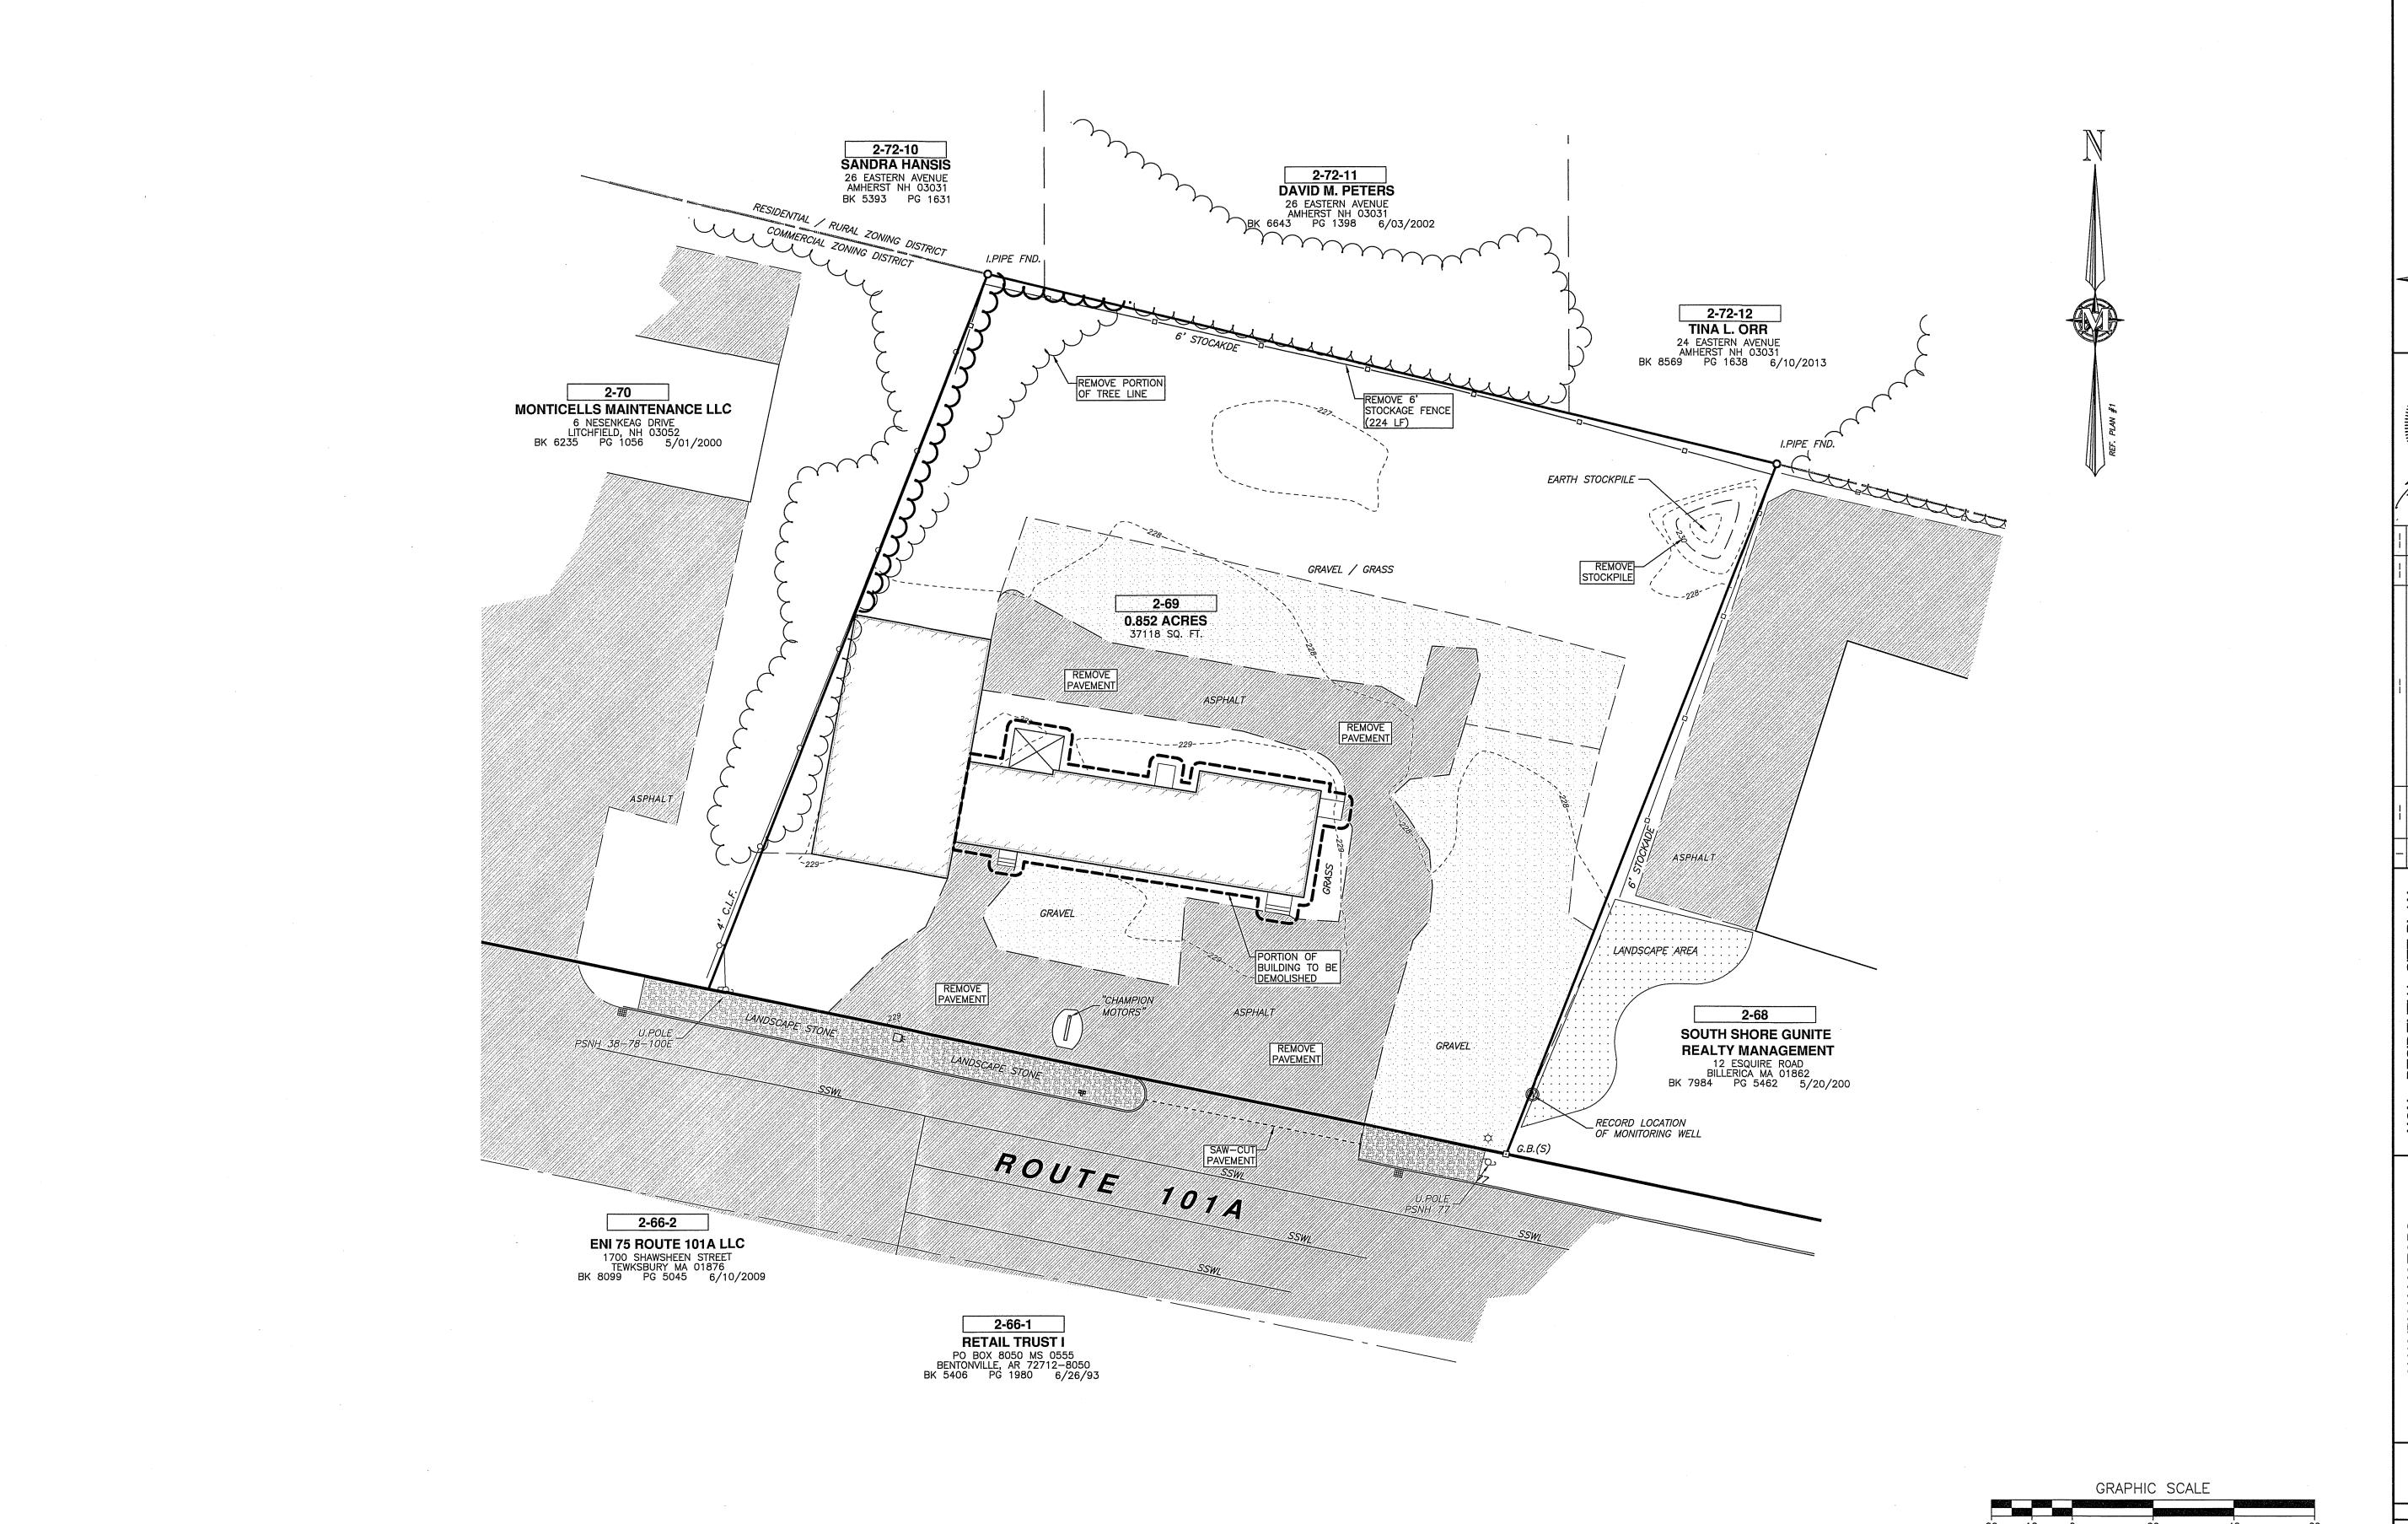

FILE: PROJECT 3772.03 IMPERIAL: 1:20 (IN:FT) SHEET NO. 3 OF 6

KEVIN M. ANDERSON No. 14746 NON - RESIDENTIAL SITE PLAN USED AUTO DEALERSH DEMOLITION PLAN


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LANDSERING | SOIL & WETLANI 31 OLD NASHUA ROAD, MERIDIANLANDSERVIC

OF NEW HAM

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- 2" PAVEMENT

BASE (304.3)

- 8" REGRADED ONSITE MATERIAL

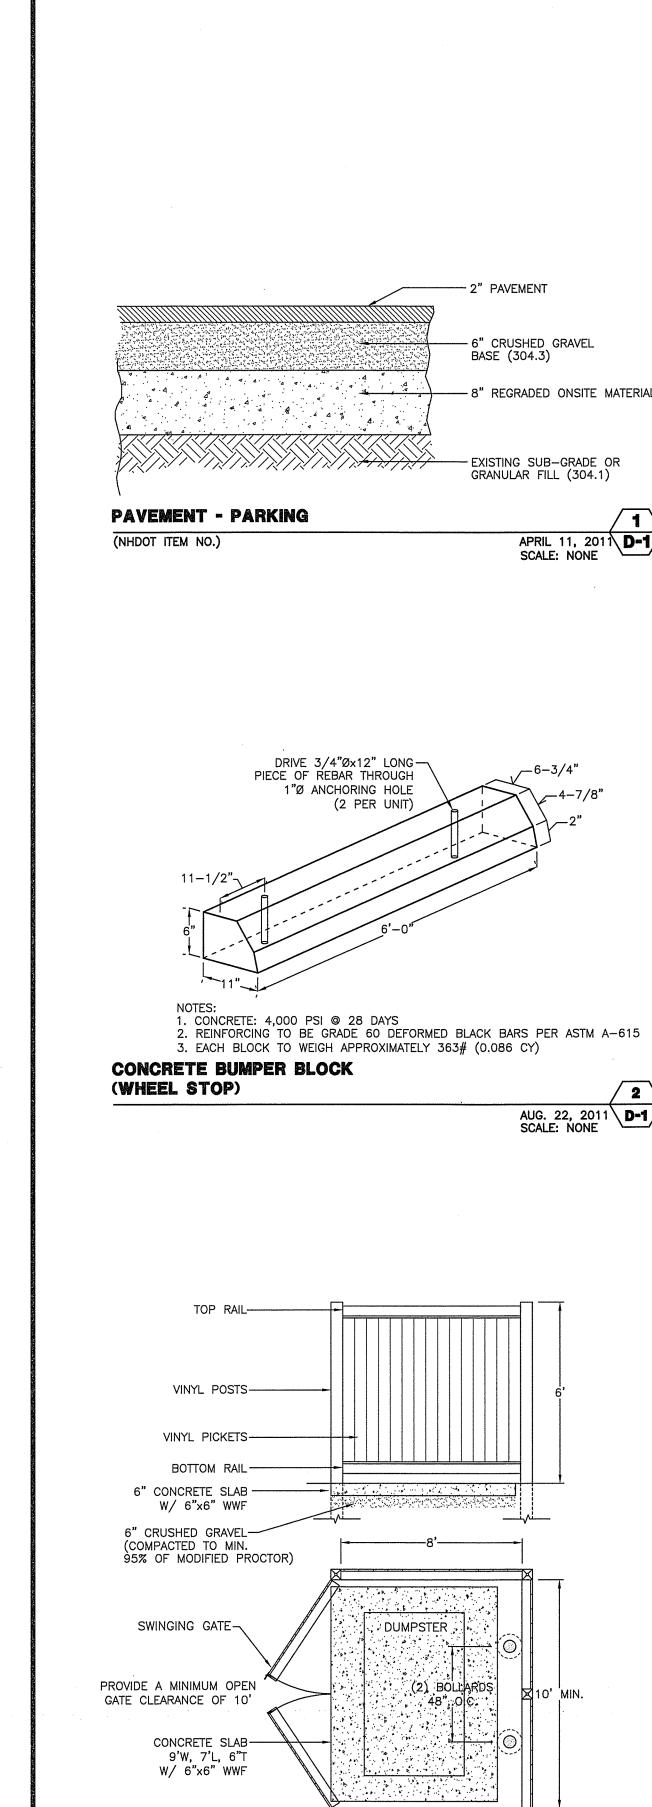GRANULAR FILL (304.1)


APRIL 11, 2011 **D-1**/

AUG. 22, 2011 **D-1** SCALE: NONE

JULY 2010 SCALE: NONE

D-1

SCALE: NONE

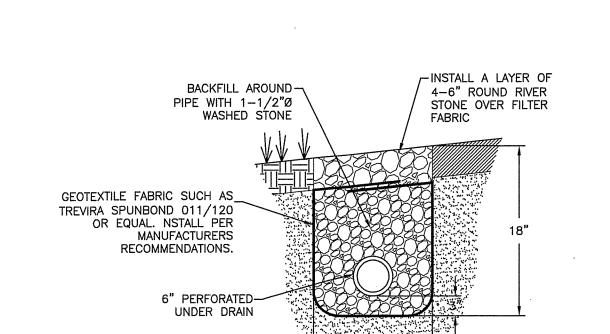

INTERCEPTOR TRENCH - SLOPE

INSPECTION PORT BY

24" (600 mm) HDPE ACCESS

CHAMBER SYSTEM - ISOLATOR ROW

STORMTECH CHAMBER SC-740 OR EQUAL

PIPE REQUIRED. USE FACTORY

PRE-FABRICATED END CAPS.

STRUCTURE

JUNE 19, 2001 **D-1** SCALE: NONE

COVER ENTIRE ROW WITH AASHTO M288 CLASS 2

NON-WOVEN GEOTEXTILE OR EQUAL

SC-740: 8' (2.4 m) WIDE STRIP

SC-310: 5' (1.5 m) WIDE STRIP/

STORMTECH/

MAY 26, 2011 SCALE: NONE **D-1**


2 LAYERS OF AASHTO M288 CLASS 1 WOVEN GEOTEXTILE

SC-740: 5'-6" (1.7 m) WIDE STRIP

SC-310: 4'-0" (1.2 m) WIDE STRIP

OR EQUAL, BETWEEN FOUNDATION STONE AND CHAMBERS

	SURFACE AREA BTM OF PRACTICE (SF)	(A) BTM OF PEA STONE	(B) BTM OF FILTER MATERIAL	(C) BOTTOM OF MULCH / STONE	(D) BASIN FLOOR ELEV
BASIN RG-1	153	225.0	225.25	226.75	227.0
BASIN RG-2	280	223.50	223.75	225.25	225.5

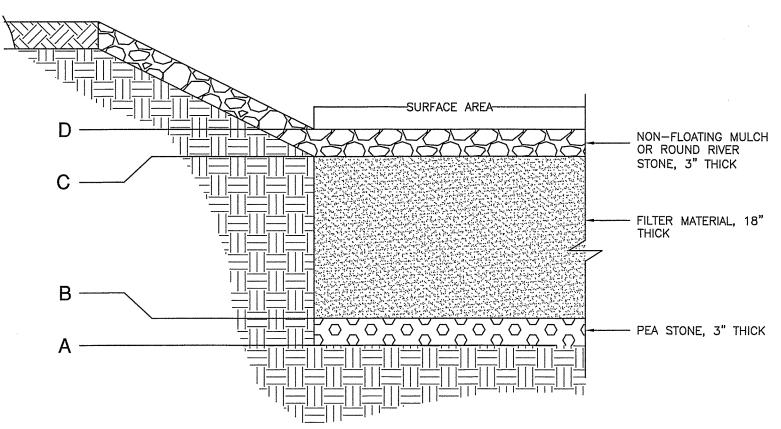

THE EXISTING ONSITE SANDY WINDSOR SOIL SHALL BE AMENDED TO PROMOTE PLANT GROWTH AND SURVIVABILITY. MIX THE FILTER MEDIA TO THE FOLLOWING RATIO: 50% SAND / 25% TOPSOIL / 25% COMPOST

2. THE MULCH LAYER SHALL BE 3 INCHES AND NON FLOATABLE. THE OPTIONAL USE OF ROUND RIVER STONE OR OTHER NON FLOATING MATERIAL CAN BE USED. FILTER FABRIC SHALL BE INSTALLED IF MATERIALS OTHER THAN MULCH ARE USED TO PREVENT SEDIMENT FROM CLOGGING THE FILTER MATERIAL LAYER.

3. DO NOT PLACE SYSTEM INTO SERVICE UNTIL THE BMP HAS BEEN PLANTED AND ITS CONTRIBUTING DRAINAGE AREA(S) HAVE BEEN FULLY STABILIZED.

4. THE BOTTOM OF THE FILTER MEDIA SHALL BE A MINIMUM OF 1 FOOT ABOVE THE SEASONAL HIGH WATER TABLE, 2 FEET IF WITHIN GROUNDWATER OR WATER SUPPLY

5. TO PREVENT DEGRADATION OF INFILTRATION FUNCTION:

A. DO NOT TRAFFIC EXPOSED SOIL SURFACE WITH CONSTRUCTION EQUIPMENT. IF FEASIBLE, PERFORM EXCAVATIONS WITH EQUIPMENT POSITIONED OUTSIDE THE LIMITS OF THE INFILTRATION COMPONENTS OF THE SYSTEM.

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KEVIN ANDERSON No. 14746

DETAILS AND DRAINAC

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PROJECT 3772.03

SHEET NO. 5 OF 6


B. DO NOT COMPACT THE EXCAVATION.

C. DO NOT DISCHARGE SEDIMENT-LADEN WATERS FROM CONSTRUCTION ACTIVITIES (RUNOFF, WATER FROM EXCAVATIONS) TO THE SYSTEM DURING ANY STAGE OF

CONSULT RAIN GARDEN PLANTING AND MAINTENANCE MANUAL SUPPLIED WITH PLANS FOR SUGGESTED PLANTS.



DEC. 15, 2015 **D-1** SCALE: NONE SCALE: NONE

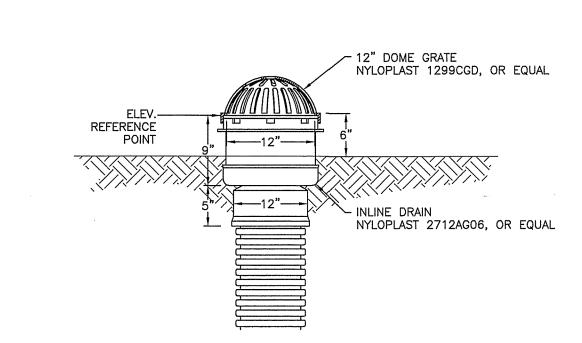


RAIN GARDEN EMERGENCY OVERFLOW

FEB. 28, 2012 **D-1** SCALE: NONE

CHAMBER SYSTEM STORMTECH CHAMBER SC-740 OR EQUAL

MAY 26, 2011 **D-1** SCALE: NONE

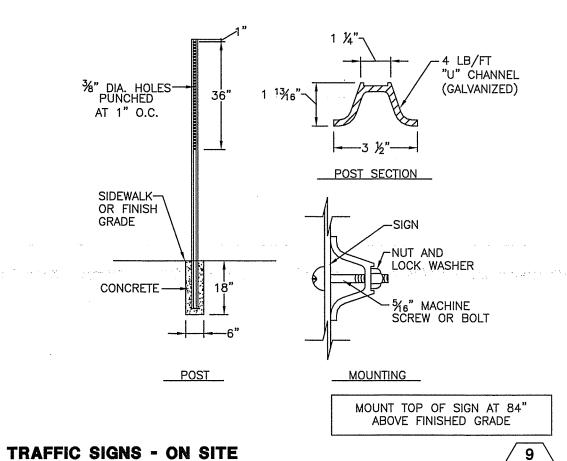


D-1 AUG. 2013

SCALE: NONE

HANDICAP PARKING - STANDARD


FEB. 16, 2001 **D-1** SCALE: NONE SCALE: NONE

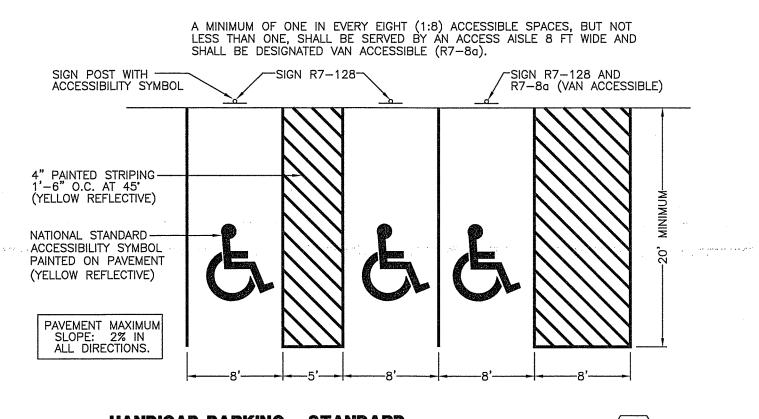

CHAMBER - STORMTECH SC-740 TOTAL NUMBER OF CHAMBERS (E) FINISH GRADE (B) BTM OF CHAMBER (C) TOP OF CHAMBER (A) BTM OF (D) TOP OF STONE 221.50 224.0 224.5 VARIES DUMPSTER . (2) BOLLARDS ACCOMMODATES 6 YARD DUMPSTER **DUMPSTER ENCLOSURE**

- INSTALL SILTATION CONTROL FENCE IN LOCATIONS SHOWN ON PLANS. EROSION AND SEDIMENTATION CONTROL MEASURES SHALL BE INSTALLED PRIOR
- 3. PULL STUMPS AND REMOVE FROM SITE OR MULCH TO USE ON-SITE FOR EROSION CONTROL. REMOVE TOPSOIL AND STOCKPILE AWAY FROM ANY WETLAND. STABILIZE STOCKPILE IMMEDIATELY BY SEEDING. PLACE SILT FENCE AROUND THE DOWN SLOPE SIDE OF EARTH STOCKPILES.
- CONSTRUCT INFILTRATION BASIN DURING INITIAL PORTION OF CONSTRUCTION, PRIOR TO ROUGH GRADING THE SITE. STABILIZE IMMEDIATELY WITH LOAM AND SEED PER THE EROSION CONTROL NOTES. DO NOT DIRECT STORM WATER RUNOFF TO BASIN UNTIL A HEALTHY VEGETATIVE COVER IS ESTABLISHED.
- ROUGH GRADE THE SITE. ALL CUT AND FILL SLOPES SHALL BE STABILIZED UPON COMPLETION OF ROUGH GRADING PER THE THE EROSION CONTROL
- 6. INSPECT AND MAINTAIN EROSION CONTROL MEASURES ON A WEEKLY BASIS AND AFTER ANY RAINFALL EVENT OF HALF AN INCH OR MORE.
- 7. DAILY, OR AS REQUIRED, CONSTRUCT TEMPORARY BERMS, DITCHES, SILTATION FENCES, SEDIMENT TRAPS, ETC. MULCH AND SEED AS REQUIRED.
- 8. FINISH GRADING THE SITE. ALL CUT AND FILL SLOPES SHALL BE LOAMED AND SEEDED WITHING 72 HOURS OF ACHIEVING FINISHED GRADE. ALL ROADWAYS AND PARKING LOTS SHALL BE STABILIZED WITHIN 72 HOURS OF ACHIEVING
- 9. PAVE ACCESS DRIVE AND CONSTRUCT CONCRETE SLABS.
- 10. APPLY 6" OF LOAM. COMPLETE PERMANENT SEEDING AND LANDSCAPING.
- 11. TEMPORARY EROSION CONTROL MEASURES SHALL BE REMOVED WHEN ALL DISTURBED AREAS HAVE BEEN STABILIZED.

CONSTRUCTION SEQUENCE

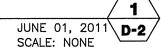

DURING CONSTRUCTION AND THEREAFTER, EROSION CONTROL MEASURES ARE TO BE IMPLEMENTED AS NOTED:

- INSTALLATION SILTATION FENCE WHERE INDICATED SHALL BE COMPLETED PRIOR TO THE START OF SITE WORK IN ANY GIVEN AREA.
- 2. SILTATION FENCES SHALL BE KEPT CLEAN DURING CONSTRUCTION AND REMOVED WHEN ALL DISTURBED AREAS HAVE A HEALTHY STAND OF VEGETATIVE COVER. EROSION CONTROL MEASURES SHALL BE INSPECTED AT LEAST ONCE A WEEK AND AFTER EVERY 0.5" OR GREATER RAINFALL.
- 3. EXISTING VEGETATION IS TO REMAIN UNDISTURBED WHEREVER POSSIBLE.
- 4. PER THE NEW HAMPSHIRE DEPARTMENT OF ENVIRONMENTAL SERVICES. THE SMALLEST PRACTICAL AREA SHALL BE DISTURBED DURING CONSTRUCTION.
- 5. THE DURATION OF TIME THAT AN AREA IS DISTURBED SHALL BE MINIMIZED. ALL NON-ACTIVE DISTURBED AREAS (ie: CLEARED FOR CONSTRUCTION BUT NOT PRESENTLY UNDERGOING CONSTRUCTION) SHALL BE STABILIZED WITHIN 28 DAYS OF DISTURBANCE. ALL DISTURBED AREAS SHALL BE STABILIZED WITHIN 72 HOURS AFTER FINAL GRADING.
- INFILTRATION BASINS SHALL BE CONSTRUCTED DURING THE INTIAL PHASE OF CONSTRUCTION AND SHALL BE STABILIZED PRIOR TO DIRECTING STORM WATER
- 7. AN AREA MAY BE CONSIDERED STABILIZED WHEN ONE OF THE FOLLOWING HAS A. BASE COURSE GRAVELS HAVE BEEN INSTALLED IN AREAS TO BE PAVED; B. A MINIMUM OF 85% VEGETATED GROWTH HAS BEEN ESTABLISHED;

C. A MINIMUM OF 3" OF NON-EROSIVE MATERIAL SUCH AS STONE OR RIPRAP

- HAS BEEN INSTALLED; OR D. EROSION CONTROL BLANKETS HAVE BEEN PROPERLY INSTALLED.
- ALL DISTURBED AREAS SHALL BE COVERED WITH A MINIMUM OF 6" OF LOAM. LOAM SHALL BE COVERED WITH THE APPROPRIATE SEED MIXTURE AS INDICATED

THE SEED MIXTURE SHALL BE APPLIED AT A RATE OF 2.5 POUNDS PER 1,000 SQ. FT. AND SHALL BE MIXED AS FOLLOWS:


TYPICAL LAWN SEED		SLOPE SEED	
CREEPING RED FESCUE	0.87 LBS.	CREEPING RED FESCUE	1.01 LBS.
KENTUCKY BLUEGRASS	0.71 LBS.	RYE GRASS	0.75 LBS.
RYE GRASS	0.58 LBS.	RED TOP	0.18 LBS.
RED TOP	0.14 LBS.	ALSIKE CLOVER	0.18 LBS.
		BIRDSFOOT TREFOIL	0.18 LBS.

APPLY LIMESTONE AND FERTILIZER ACCORDING TO SOIL TEST RECOMMENDATIONS. IF SOIL TESTING IS NOT FEASIBLE ON SMALL OR VARIABLE SITES, OR WHERE TIMING IS CRITICAL, FERTILIZER MAY BE APPLIED AT THE RATE OF 600 POUNDS PER ACRE OR 13.8 POUNDS PER 1,000 SQUARE FEET OF LOW PHOSPHATE FERTILIZER (N-P205-K20) OR EQUIVALENT (LOW PHOSPHORUS FERTILIZER IS DEFINED BY THE COMPREHENSIVE SHORELAND PROTECTION ACT AS LESS THAN 2% PHOSPHORUS). APPLY LIMESTONE (EQUIVALENT TO 50 PERCENT CALCIUM PLUS MAGNESIUM OXIDE) AT A RATE OF 3 TONS PER ACRE (138 LB. PER 1,000 SQUARE FEET).

FERTILIZER SHOULD BE RESTRICTED TO A LOW PHOSPHATE, SLOW RELEASE NITROGEN FERTILIZER WHEN APPLIED TO AREAS BETWEEN 25 FEET AND 250 FEET FROM A SURFACE WATER BODY AS SPECIFIED BY THE COMPREHENSIVE SHORELAND PROTECTION ACT (SLOW RELEASE FERTILIZERS MUST BE AT LEAST 50% SLOW RELEASE NITROGEN COMPONENT). NO FERTILIZER EXCEPT LIMESTONE SHOULD BE APPLIED WITHIN 25 FEET OF THE SURFACE WATER. THESE LIMITATIONS ARE REQUIREMENTS.

- 10. PERMANENT OR TEMPORARY COVER MUST BE IN PLACE BEFORE THE GROWING SEASON ENDS. WHEN SEEDED AREAS ARE MULCHED, PLANTINGS MAY BE MADE FROM EARLY SPRING TO EARLY OCTOBER. WHEN SEEDED AREAS ARE NOT MULCHED, PLANTINGS SHOULD BE MADE FROM EARLY SPRING TO MAY 20 OR FROM AUGUST 10 TO SEPTEMBER 15. NO DISTURBED AREA SHALL BE LEFT EXPOSED DURING THE WINTER MONTHS.
- 11. THE SITE CONTRACTOR SHALL MAINTAIN A VIGOROUS DUST CONTROL PROGRAM THROUGHOUT THE CONSTRUCTION PROCESS. EXPOSED EARTH SHALL BE KEPT MOIST OR MULCHED AT ALL TIMES TO PREVENT DUST FORMATION. SPECIAL ATTENTION SHALL BE PAID TO HIGH TRAFFIC AREAS.

EARTH REMOVAL **EROSION CONTROL NOTES**

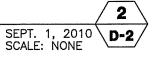

- 1. ALL CONSTRUCTION SHALL CONFORM TO THE APPLICABLE REQUIREMENTS AND SPECIFICATIONS OF THE TOWN OF AMHERST, AS SET FORTH IN THE CURRENT EDITION OF THE "CODE OF ORDINANCES - CITY OF - BEDFORD, NEW HAMPSHIRE". OTHERWISE, ALL CONSTRUCTION SHALL CONFORM TO THE CURRENT EDITION OF "STANDARD SPECIFICATIONS FOR ROAD AND BRIDGE CONSTRUCTION - STATE OF NEW HAMPSHIRE DEPARTMENT OF TRANSPORTATION.
- 2. THE CONTRACTOR SHALL BE RESPONSIBLE FOR VERIFYING THE LOCATION, SIZE, AND ELEVATION OF ALL EXISTING UTILITIES SHOWN OR NOT SHOWN ON THESE PLANS AND SHALL VERIFY THAT ALL THE INFORMATION SHOWN HEREON IS CONSISTENT, COMPLETE, ACCURATE, AND CAN BE CONSTRUCTED PRIOR TO AND/OR DURING CONSTRUCTION. MERIDIAN LAND SERVICES, INC., AS DESIGN ENGINEER, SHALL BE NOTIFIED IN WRITING OF ANY DISCREPANCIES, ERRORS, OMISSIONS, OR EXISTING UTILITIES FOUND INTERFERING WITH THE PROPOSED CONSTRUCTION SO THAT REMEDIAL ACTION MAY BE TAKEN BEFORE PROCEEDING WITH THE WORK.
- 3. THE OWNER AND/OR CONTRACTOR SHALL VERIFY ALL ZONING REQUIREMENTS FOR CONFORMANCE PRIOR TO CONSTRUCTION.
- 4. THE CONTRACTOR SHALL CONTACT "DIGSAFE" 72 HOURS PRIOR TO THE START OF CONSTRUCTION (1-800-255-4977 IN NH, 1-888-344-7233 IN MA).
- 5. COMPLIANCE WITH ALL APPLICABLE REGULATIONS AND SPECIAL CONDITIONS OF TOWN/CITY AGENCIES, SUCH AS THE PLANNING BOARD, CONSERVATION COMMISSION, AND OTHERS, IS MANDATORY AND IS THE RESPONSIBILITY OF THE OWNER.
- 6. ANY ALTERATION OF THIS DESIGN OR CHANGE DURING CONSTRUCTION MAY REQUIRE APPROVAL OF VARIOUS TOWN BOARDS OR AGENCIES AND SHALL BE DISCUSSED WITH THE OWNER AND MERIDIAN LAND SERVICES, INC. PRIOR TO CONSTRUCTION.
- 7. ALL DRAINAGE STRUCTURES SHALL CONFORM TO NHDOT STANDARDS.
- 8. THE CONTRACTOR IS RESPONSIBLE FOR CONTACTING THE APPROPRIATE TOWN DEPARTMENT PRIOR TO CONSTRUCTION TO ARRANGE FOR INSPECTIONS OF THE
- 9. THE CONTRACTOR IS RESPONSIBLE FOR MAINTAINING ACCURATE AS—BUILT INFORMATION OF ALL WORK, ESPECIALLY UNDERGROUND CONSTRUCTION OF UTILITY LINES, SERVICES, CONNECTIONS, ETC. AND APPROPRIATE TIES TO ABOVE GROUND PERMANENT STRUCTURES, FIELD SURVEY COORDINATES, OR SOME OTHER METHOD OF ESTABLISHING THE AS-BUILT CONDITION OF ALL CONSTRUCTION.

CONSTRUCTION NOTES

NOV. 13, 2009 \ D-2 SCALE: NONE

- 1. TEMPORARY PROTECTION OF DISTURBED AREAS SHALL BE IMPLEMENTED WHERE A TEMPRORARY STAND OF GRASS OR SMALL GRAINS WILL NORMALLY PRODUCE SUFFICIENT COVER TO RETARD EROSION AND REDUCE SEDIMENT.
- 2. USE OF TEMPORARY SEEDING SHALL BE IMPLEMENTED WHEN A DISTURBED AREA OR MATERIAL STOCKPILE WILL BE INACTIVE FOR A PROLONGED PERIOD
- 3. ALL ESSENTIAL GRADING SUCH AS DIVERSIONS. DAMS, DITCHES, AND DRAINS NEEDED TO PREVENT GULLYING AND REDUCE SILTATION SHALL BE COMPLETED
- 4. PREPARE SEEDBED BY REMOVEING ALL STONES, TRASH AND STUMPING DEBRIS THAT WILL INTERFERE WITH SEEDING AREA. WHERE FEASIBLE, TILL THE SOIL TO A DEPTH OF ABOUT 3 INCHES TO PREPARE SEEDBED AND MIX FERTILIZER INTO THE SOIL. THE SEEDBED SHOULD BE LEFT IN A FIRM AND SMOOTH CONDITION. THE LAST TILLAGE OPERATIONS SHOULD BE PERFORMED ACROSS THE SLOPE.
- 5. A MINIMUM OF 300 POUNDS PER ACRE (7 LBS. PER 1,000 SQ.FT.) OF 10-10-10 FERTILIZER, OR ITS EQUIVALENT, SHALL BE UNIFORMLY SPREAD OVER THE AREA PRIOR TO BEING INCORPORATED INTO THE SOIL.
- 6. THE SEED SHALL BE SPREAD UNIFORMLY OVER THE AREA. AFTER SEEDING, THE SOIL SHOULD BE FIRMED BY ROLLING OR PACKING. WHERE ROLLING OR DISKING, OR DRAGGING.
- 7. HAY OR STRAW MULCH MAY BE NECCESSARY TO PROMOTE SEED GERMINATION IN DRY AND/OR INFERTILE CONDITIONS.
- 8. PLANT SELECTION AND APPLICATION RATES:

SPECIES	RATE 1 (LBS/AC.)	RATE 2 (LBS/1,000 S.F.)	REMARKS
WINTER RYE	112	2.5	FALL, 8/15 TO 9/15 PLANT 1.0 INCH DEEP
OATS	80	2.0	SPRING PRIOR TO 5/15 PLANT 1.0 INCH DEEP
ANNUAL RYEGRASS	40	1.0	QUICK, SHORT DURATION GOOD APPEARANCE EARLY SPRING & FALL PLANT 0.25 INCH DEEP
PERENNIAL RYEGRASS	30	0.7	LASTS LONGER THAN ANNUAL LATE SPRING & FALL MULCHING WILL ALLOW USE ALL SEASON PLANT 0.5 INCH DEEP


SEEDING FOR TEMPORARY PROTECTION OF DISTURBED AREAS

AUGUST 30, 2006 \ D-2/ SCALE: NONE

- ALL POST-DEVELOPMENT VEGETATED AREAS WHICH DO NOT EXHIBIT A MINIMUM OF 85% VEGETATED GROWTH BY OCTOBER 15TH, OR WHICH ARE DISTURBED AFTER OCTOBER 15TH, SHALL BE STABILIZED BY SEEDING AND INSTALLING EROSION CONTROL BLANKETS ON SLOPES GREATER THAN 3:1, AND SEEDING AND PLACING 3 TO 4 TONS OF MULCH PER ACRE, SECURED WITH ANCHORED NETTING, ELSEWHERE. THE PLACEMENT OF EROSION CONTROL BLANKETS OR MULCH AND NETTING SHALL NOT OCCUR OVER ACCUMULATED SNOW OR ON FROZEN GROUND AND SHALL BE COMPLETED IN ADVANCE OF THAW OR SPRING MELT EVENTS.
- ALL DITCHES OR SWALES WHICH DO NOT EXHIBIT A MINIMUM OF 85% VEGETATED GROWTH BY OCTOBER 15TH, OR WHICH ARE DISTURBED AFTER OCTOBER 15TH, SHALL BE STABILIZED WITH STONE RIPRAP OR EROSION CONTROL BLANKETS APPROPRIATE FOR THE DESIGN FLOW CONDITION.
- AFTER NOVEMBER 15TH, INCOMPLETE ROAD OR PARKING SURFACES SHALL BE PROTECTED WITH A MINIMUM OF 3 INCHES OF CRUSHED GRAVEL PER NHDOT ITEM 304.3. OR IF CONSTRUCTION IS TO CONTINUE THROUGH THE WINTER SEASON BE CLEARED OF ANY ACCUMULATED SNOW AFTER EACH STORM EVENT.

WINTER CONSTRUCTION

OCT. 12, 2009 \ D-2 SCALE: NONE

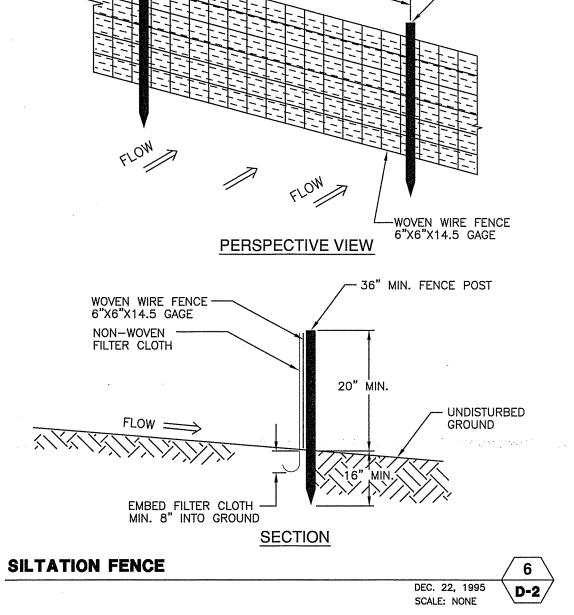

FENCE POST

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DETAIL

3772103A.dw PROJECT 3772.03 SHEET NO. 6 OF 6

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E NEW HAA

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